


NOTES
 1. LOCATION OF ALL SCORING LINES TO BE APPROVED BY THE RESIDENT ENGINEER PRIOR TO PLACING ANY CONCRETE PAVEMENTS.
 2. WHERE POSSIBLE, SCORE LINES SHALL ALIG WITH EXISTING SCORING LINES THAT REMAIN IN ADJACENT PANELS.

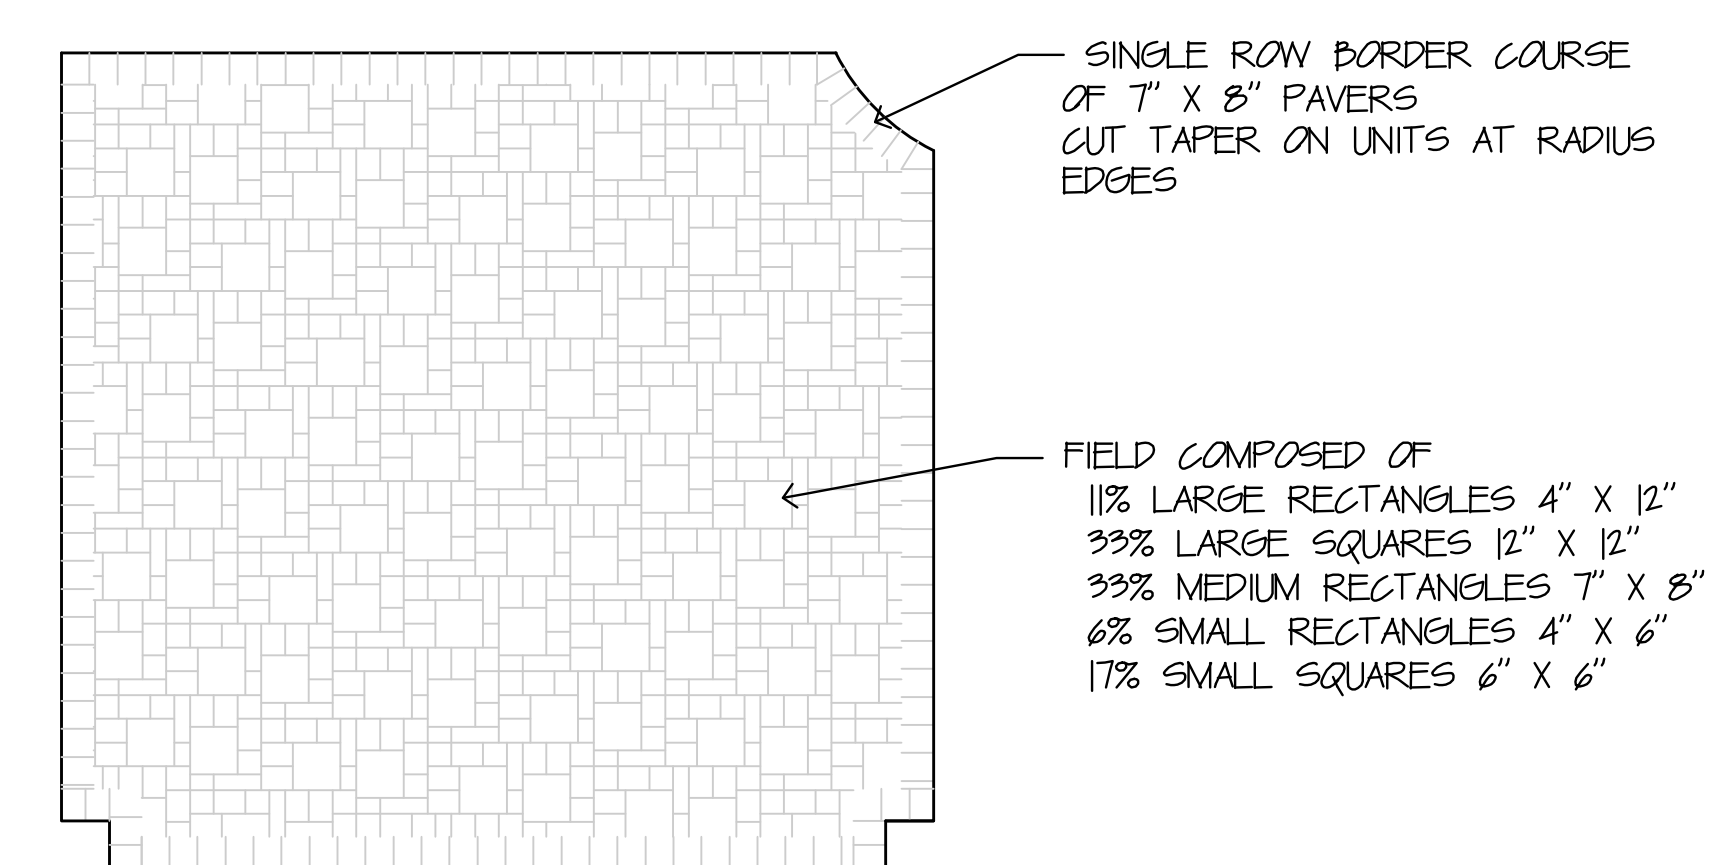

L14 TYPICAL PRECAST CONCRETE PAVER PAVING PLAN
 SCALE: 1/4" = 1'-0"

**ALL-Lima
 Downtown
 Streetscape
 Renovation**
 PID 85907
 Lima, Ohio

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 • Landscape Architects • Planners •

LEGEND

BRICK PAVEMENT SEE DETAIL E9/LA02	CONCRETE OVERLAY ALTERNATE #4
BRICK PAVERS ON NEW CONC. SUBSLAB SEE DETAIL E9/LA02	FULL DEPTH ASPHALT PAVEMENT SEE DETAIL A1/LA01
4" CONCRETE PAVEMENT SEE DETAIL G6/LA01	WALL CURB SEE DETAIL D1/LA01
6" CONCRETE PAVEMENT SEE DETAIL D6/LA01	COMBINATION CURB & WALK SEE DETAIL G8/LA01
8" CONCRETE PAVEMENT SEE DETAIL A6/LA01	TREE GRATE SEE DETAIL A9/LA04
DECORATIVE CONC. UNIT PAVERS SEE DETAIL E9/LA02	BOLLARD SEE DETAIL K6/LA01

Date	12/07/2009	Project No.	08002
Proj. Architect		Checked By	
Drawn By		Description	
Revision			
		Design Development	09/11/09
		100% CD	12/07/09

**TOWN SQUARE
 SOUTH
 PAVEMENT PLAN**

L206

